

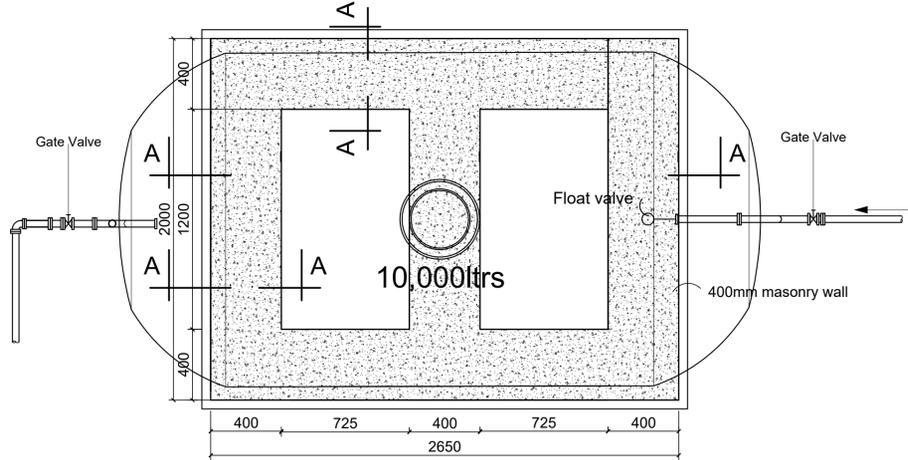


TYPICAL MASONRY WALL PLINTH FOR WATER TANK

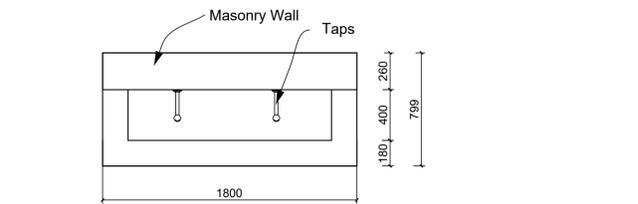


WATER RESERVOIR PLAN
SCALE -1:25


WATER TANKER SUPPORT DETAILS

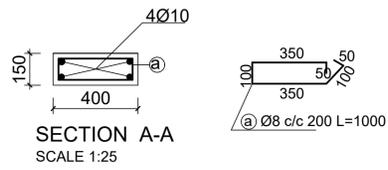


HAND WASH PLAN
Scale 1:25

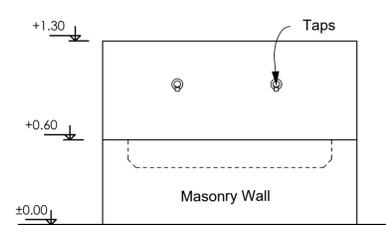


FRONT ELEVATION
Scale 1:25

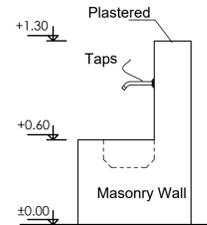


SIDE ELEVATION
Scale 1:25

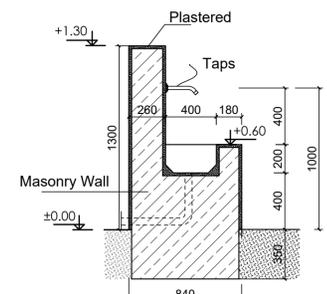

HWT DETAIL
Scale 1:25

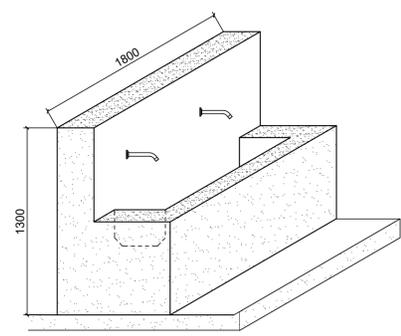


HAND WASH TROUGH (HWT) PERSPECTIVE VIEW
Scale 1:25

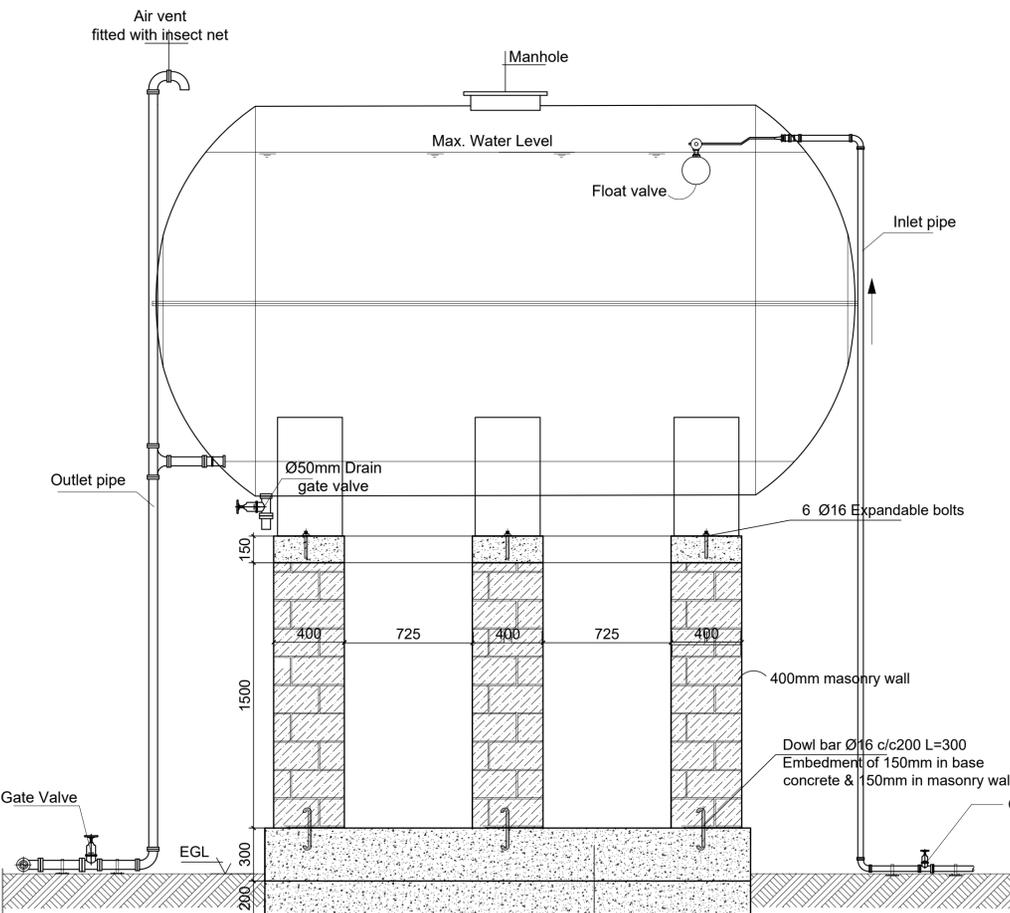

SECTION A-A
SCALE -1:25

WATER TANK PLINTH
SCALE -1:25

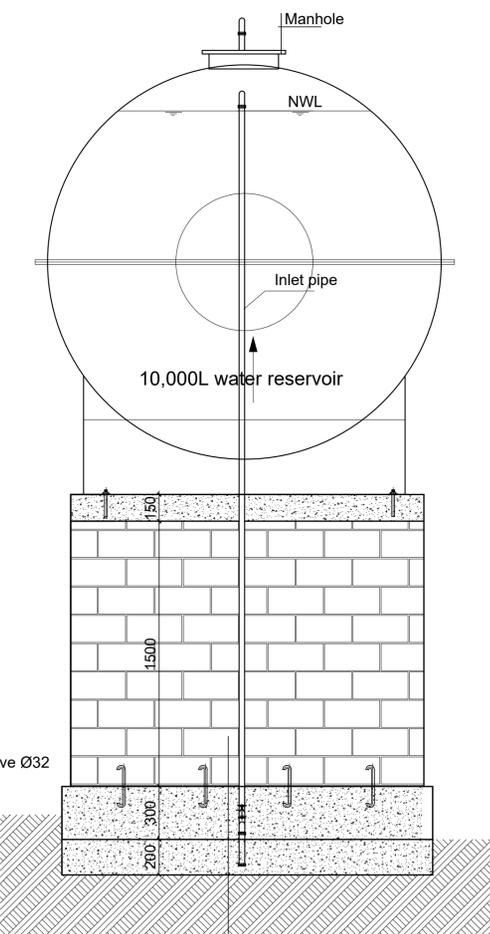

- 400mm masonry wall
- 300mm thick stone boulders with cement mortar
- Min. 200mm thick well compacted selected fill (95% proctor)
- Natural soil

GENERAL NOTES:


K - WATER RESERVOIR

Rev.	Date	Description	Approved
0			

KEY PLAN

Funded By: United Nations Higher Commission for Refugees Office for the AU (UNHCR)		Partner: United Nations Higher Commission for Refugees Office for the AU (UNHCR)	
Program: Rehabilitation of UNHCR One-Stop-Shop (OSS) Registration Model		Implemented By: UNOPS ETHIOPIA OPERATIONAL HUB	
Project Name: KULE OSS CENTER		Design: UNOPS ETHIOPIA OPERATIONAL HUB	

WATER RESERVOIR PLAN HAND WASH TROUGH DETAILS				
Designed by	Discipline:	Dr. No:	Tot. No:	Rev. No:
MM	AR	16	16	R0
Drawn:	Checked:	Approved:	Size:	Scale:
MM	BM	SM	A1	1:25
Date:	02 / 05 / 2021	Rev.:	0	

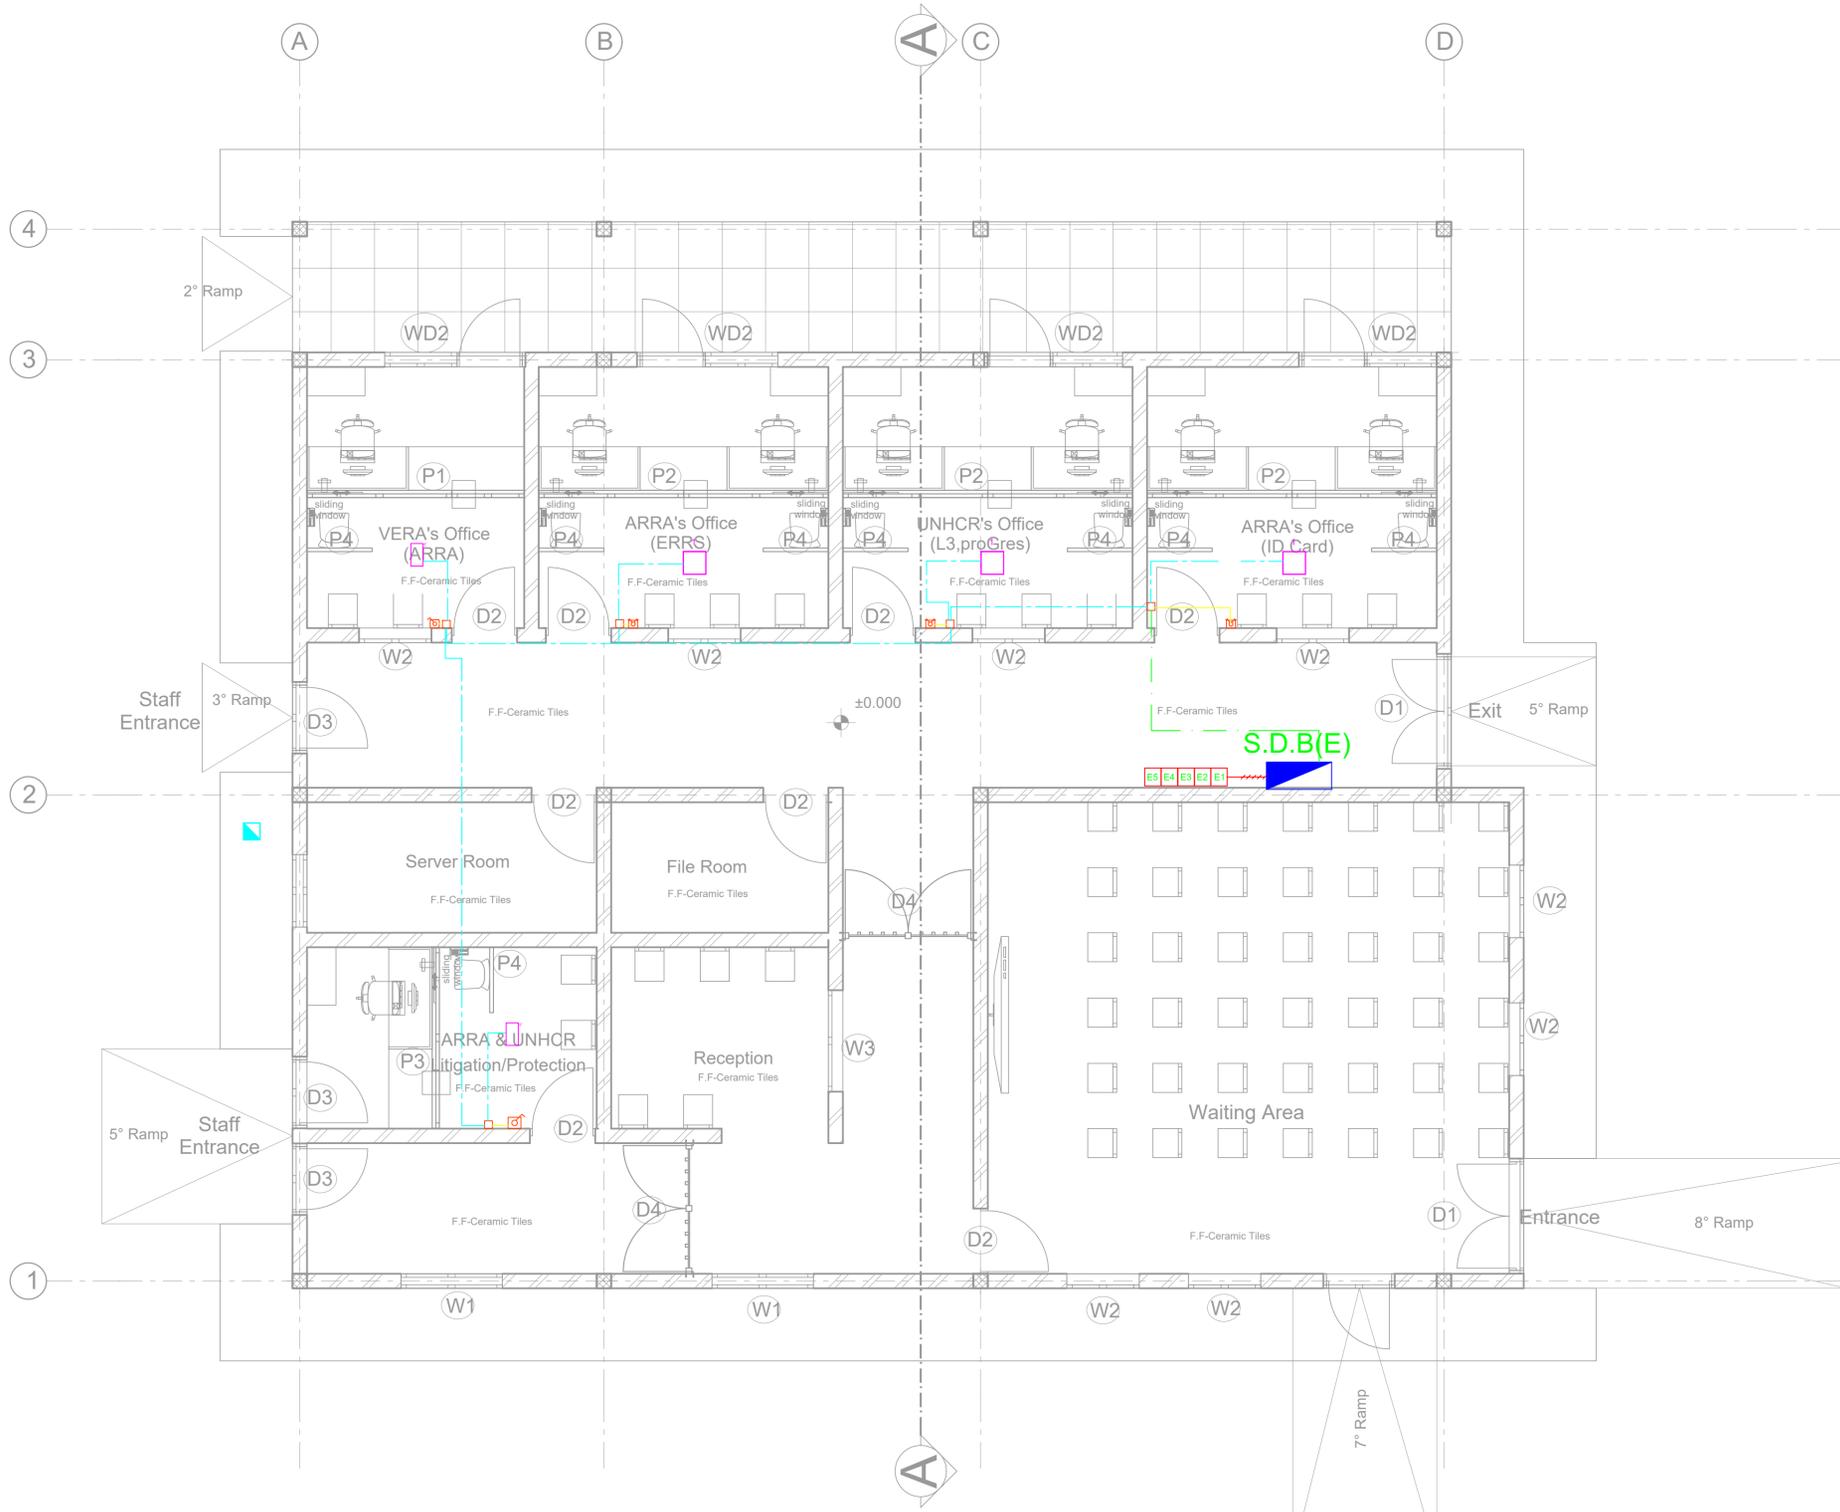

ELECTRICAL LAYOUT PLAN
SC 1:50

GENERAL NOTES:

LEGEND

- NEW PARTITION
- EXISTING WALL

LEGEND ROOM LIGHTING	
	DESCRIPTION: RECESSED MR 1500
	DESCRIPTION: RECESSED MR 1500 20" x 20"
	DESCRIPTION: RECESSED MR 1500 20" x 20" (4000K, 3000lm)
ELECTRICAL ACCESSORIES	
	DESCRIPTION: 1-WAY SWITCH
	DESCRIPTION: 2-WAY SWITCH
	DESCRIPTION: 3-WAY SWITCH
	DESCRIPTION: 100-WAY SWITCH
CABLES LEGEND	
	DESCRIPTION: CABLE IN GROUND
	DESCRIPTION: CABLE IN CONDUIT
	DESCRIPTION: CABLE IN TRAY
	DESCRIPTION: CABLE IN RACEWAY
	DESCRIPTION: CABLE IN DUCT
	DESCRIPTION: CABLE IN CHASE
	DESCRIPTION: CABLE IN TUNNEL
	DESCRIPTION: CABLE IN MANHOLE
	DESCRIPTION: CABLE IN PULL BOX
	DESCRIPTION: CABLE IN JUNCTION BOX
	DESCRIPTION: CABLE IN TRANSIT BOX
	DESCRIPTION: CABLE IN TERMINAL BOX
	DESCRIPTION: CABLE IN DISTRIBUTION BOX
	DESCRIPTION: CABLE IN CONTROL BOX
	DESCRIPTION: CABLE IN SIGNAL BOX
	DESCRIPTION: CABLE IN POWER BOX
	DESCRIPTION: CABLE IN LIGHTING BOX
	DESCRIPTION: CABLE IN FAN BOX
	DESCRIPTION: CABLE IN MOTOR BOX
	DESCRIPTION: CABLE IN HEATING BOX
	DESCRIPTION: CABLE IN COOLING BOX
	DESCRIPTION: CABLE IN VENTILATION BOX
	DESCRIPTION: CABLE IN EXHAUST BOX
	DESCRIPTION: CABLE IN INTAKE BOX
	DESCRIPTION: CABLE IN FRESH AIR BOX
	DESCRIPTION: CABLE IN OUTDOOR AIR BOX
	DESCRIPTION: CABLE IN RETURN AIR BOX
	DESCRIPTION: CABLE IN EXHAUST AIR BOX
	DESCRIPTION: CABLE IN INTAKE AIR BOX
	DESCRIPTION: CABLE IN FRESH AIR BOX
	DESCRIPTION: CABLE IN OUTDOOR AIR BOX
	DESCRIPTION: CABLE IN RETURN AIR BOX
	DESCRIPTION: CABLE IN EXHAUST AIR BOX
	DESCRIPTION: CABLE IN INTAKE AIR BOX
	DESCRIPTION: CABLE IN FRESH AIR BOX
	DESCRIPTION: CABLE IN OUTDOOR AIR BOX
	DESCRIPTION: CABLE IN RETURN AIR BOX
	DESCRIPTION: CABLE IN EXHAUST AIR BOX
	DESCRIPTION: CABLE IN INTAKE AIR BOX
	DESCRIPTION: CABLE IN FRESH AIR BOX
	DESCRIPTION: CABLE IN OUTDOOR AIR BOX
	DESCRIPTION: CABLE IN RETURN AIR BOX
	DESCRIPTION: CABLE IN EXHAUST AIR BOX
	DESCRIPTION: CABLE IN INTAKE AIR BOX
	DESCRIPTION: CABLE IN FRESH AIR BOX
	DESCRIPTION: CABLE IN OUTDOOR AIR BOX
	DESCRIPTION: CABLE IN RETURN AIR BOX
	DESCRIPTION: CABLE IN EXHAUST AIR BOX
	DESCRIPTION: CABLE IN INTAKE AIR BOX
	DESCRIPTION: CABLE IN FRESH AIR BOX
	DESCRIPTION: CABLE IN OUTDOOR AIR BOX
	DESCRIPTION: CABLE IN RETURN AIR BOX
	DESCRIPTION: CABLE IN EXHAUST AIR BOX
	DESCRIPTION: CABLE IN INTAKE AIR BOX
	DESCRIPTION: CABLE IN FRESH AIR BOX
	DESCRIPTION: CABLE IN OUTDOOR AIR BOX
	DESCRIPTION: CABLE IN RETURN AIR BOX
	DESCRIPTION: CABLE IN EXHAUST AIR BOX
	DESCRIPTION: CABLE IN INTAKE AIR BOX
	DESCRIPTION: CABLE IN FRESH AIR BOX
	DESCRIPTION: CABLE IN OUTDOOR AIR BOX
	DESCRIPTION: CABLE IN RETURN AIR BOX
	DESCRIPTION: CABLE IN EXHAUST AIR BOX
	DESCRIPTION: CABLE IN INTAKE AIR BOX
	DESCRIPTION: CABLE IN FRESH AIR BOX
	DESCRIPTION: CABLE IN OUTDOOR AIR BOX
	DESCRIPTION: CABLE IN RETURN AIR BOX
	DESCRIPTION: CABLE IN EXHAUST AIR BOX
	DESCRIPTION: CABLE IN INTAKE AIR BOX
	DESCRIPTION: CABLE IN FRESH AIR BOX
	DESCRIPTION: CABLE IN OUTDOOR AIR BOX
	DESCRIPTION: CABLE IN RETURN AIR BOX
	DESCRIPTION: CABLE IN EXHAUST AIR BOX
	DESCRIPTION: CABLE IN INTAKE AIR BOX
	DESCRIPTION: CABLE IN FRESH AIR BOX
	DESCRIPTION: CABLE IN OUTDOOR AIR BOX
	DESCRIPTION: CABLE IN RETURN AIR BOX
	DESCRIPTION: CABLE IN EXHAUST AIR BOX
	DESCRIPTION: CABLE IN INTAKE AIR BOX
	DESCRIPTION: CABLE IN FRESH AIR BOX
	DESCRIPTION: CABLE IN OUTDOOR AIR BOX
	DESCRIPTION: CABLE IN RETURN AIR BOX
	DESCRIPTION: CABLE IN EXHAUST AIR BOX
	DESCRIPTION: CABLE IN INTAKE AIR BOX
	DESCRIPTION: CABLE IN FRESH AIR BOX
	DESCRIPTION: CABLE IN OUTDOOR AIR BOX
	DESCRIPTION: CABLE IN RETURN AIR BOX
	DESCRIPTION: CABLE IN EXHAUST AIR BOX
	DESCRIPTION: CABLE IN INTAKE AIR BOX
	DESCRIPTION: CABLE IN FRESH AIR BOX
	DESCRIPTION: CABLE IN OUTDOOR AIR BOX
	DESCRIPTION: CABLE IN RETURN AIR BOX
	DESCRIPTION: CABLE IN EXHAUST AIR BOX
	DESCRIPTION: CABLE IN INTAKE AIR BOX
	DESCRIPTION: CABLE IN FRESH AIR BOX
	DESCRIPTION: CABLE IN OUTDOOR AIR BOX
	DESCRIPTION: CABLE IN RETURN AIR BOX
	DESCRIPTION: CABLE IN EXHAUST AIR BOX
	DESCRIPTION: CABLE IN INTAKE AIR BOX
	DESCRIPTION: CABLE IN FRESH AIR BOX

- GENERAL NOTES:
- The implementation of the different components should be signed by the contractor in the implementation phase, with the approval of the architectural project.
 - The dimensions are given in millimeters, the contractor must confirm them in place and all dimensions must be confirmed with the architectural project.
 - All work must be done with particular care in order not to damage the pre-existing installation, to ensure the safety of the building and the workers.

Rev.	Date	Description	Approved
0			
1			
2			
3			
4			
5			
6			
7			
8			
9			
10			

KEY PLAN

Funded By:		Partner:	
United Nations Higher Commission for Refugees Office for the AU (UNHCR)	United Nations Higher Commission for Refugees Office for the AU (UNHCR)		
Program:		Implemented By:	
Rehabilitation of UNHCR One-Stop-Shop (OSS) Registration Model	UNOPS	ETHIOPIA OPERATIONAL HUB	
Project Name:		Design:	
Kule OSS Center	UNOPS	ETHIOPIA OPERATIONAL HUB	

LIGHTING

Designed by:	Discipline:	Dr. No.:	Tot. No.:	Rev. No.:
YG	EL	01	05	R0
Drawn:	Checked:	Approved:	Size:	Scale:
MA	YG		A1	1:50
Date:	Rev.:			
02 / 10 / 2021	0			

